

Historic Preservation Commission Department of Planning, Housing, and Zoning

County Commissioners Hearing Room 400 High Street Chestertown, Maryland

AGENDA

June 22, 2023 6:00 p.m.

Members of the public are welcome to attend meetings in person or via conference call.

Public participation and audio-only call-in number:

- 1. Dial **1-872-239-8359**
- 2. Enter Conference ID: 804 087 253#

Members of the public are asked to mute their phones/devices, until the Commission Chair opens the floor for comment.

MINUTES

Request a motion to adopt the minutes of April 6, 2023, as presented.

APPLICATIONS FOR REVIEW

John Kennedy House – Certificate of Appropriateness Application – Installation of Solar Panels 11943 Augustine Herman Hwy, Kennedyville

GENERAL DISCUSSION

Invitation to Serve as a Consulting Party – Cypress Branch Dam Removal Project

Discussion of Member Appointments

STAFF REPORTS

ADJOURN

Meetings are conducted in Open Session unless otherwise indicated. All or part of the Historic Preservation Commission meetings can be held in closed session under the authority of the MD Open Meetings Law by vote of the members. Breaks are at the call of the Chairman. Meetings are subject to audio and video recordings. All applications will be given the time necessary to assure full public participation and a fair and complete review of all projects. Agenda items are subject to change due to cancellations.

Kent County Historic Preservation Commission Meeting Summary

The Kent County Historic Preservation Commission (HPC) met on Thursday, April 6, 2023, at 5:30 p.m. in the County Commissioners' Hearing Room at 400 High Street, Chestertown, Maryland. It was a hybrid meeting, and the following HPC members were in attendance: Elizabeth Beckley (remotely), Jeremy Rothwell, Max Ruehrmund, and Jennifer Moore. Staff in attendance were Mike Moulds, PE, Director of Public Works (remotely); William Mackey, DPHZ Director; Penelope Young-Carrasquillo, Grants Manager; and Campbell Safian, Planning Specialist.

Jeremy Rothwell called the meeting to order at 5:30 p.m.

MINUTES

Mr. Ruehrmund moved to accept the minutes of October 30, 2020, and November 29, 2022, without correction. Ms. Moore seconded the motion. The motion passed with all in favor.

GENERAL DISCUSSION / WORK SESSION

Discussion of the current condition and proposed next steps for Turner's Creek Granary:

- The Department of Public Works (DPW) has installed a fence around the building.
- An application for grant funding from the National Trust for Historic Preservation Bartus Trew Providence Preservation Fund must be submitted before the deadline of June 15, 2023.
- Members of the Commission spoke in opposition to demolishing the granary building to create a memorial or pavilion in the granary's honor.
- It must be determined whether Program Open Space (POS) funding is available to support the building restoration project.
- Before the Commissioners' meeting on April 18, Ms. Beckley and Mr. Ruehrmund will go onsite and assess the current condition of the building to better understand the potential cost of restoration.
- Mr. Moulds and DPW received a cost estimate of roughly \$20,000 to stabilize the building's I-beams.
- The Commission recommends asking Gary Gredell, P.E, Principle of Gredell & Associates, for a cost estimate to update the 2009 Structural Condition Assessment.
- Members of the Commission would like to schedule a phone call with Gail Owings, Executive Director of the Stories of the Chesapeake Heritage Area, to discuss the National Park Service Paul Bruhn Historic Revitalization Grants.
- Potential uses for the granary building, post-restoration, will continue to be explored.
- Mr. Ruehrmund requested a copy of a site plan of the entire property.
- The HPC will present their findings to the County Commissioners at the meeting on April 18 at 6pm.

ADJOURNMENT

Elizabeth Beckley, Chair

| Ms. | Moore | moved | to | adjourn | the | meeting. | Mr. | Ruehrmund | seconded. | The | meeting | adjourned | at |
|------|--------|----------|-----|---------|-----|----------|-----|-----------|-----------|-----|---------|-----------|----|
| appı | oximat | ely 6:40 | p.1 | m. | | | | | | | | | |
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| | | | | | | | | | | | | | |

Campbell Safian, Planning Specialist

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Kent County Historic Preservation Commission

Certificate of Appropriateness Application

| For Office Use | Only |
|---|--|
| Building Permit # (if applies): Certificate Application # | THE COUNTY |
| HPC Hearing Date:/ Application Accepted a | |
| HPC/Staff Decision: Certificate of Appropriateness Granted: | SOUTH PROPERTY OF STREET STREET, STREET STREET, STREET STREET STREET, STREET STREET, S |
| Rejected: // | |
| Deferred for Information/Consultation: | , , |
| Ceretred for Allion Markety Constitutions | |
| Please print or type. Applications must be received | d at least 10 days prior to the hearing. |
| 1. APPLICANT | |
| Name: Power Factor - Cary Shank | |
| Address: 8240 Beachwood Road | |
| Baltimore, Md. 21222 | |
| Home Phone: () Work | Phone: (443) 559 - 0174 |
| Owner Name and Address (if other than applicant): | |
| Francis Bonass, 11943 Augustine Herman Hwy Kenne | dyville, Md 21645 |
| | Zoning Classification: |
| 3. TYPE OF CHANGE (check all that apply) | G |
| ☐ Fence/Wall ☐ Windows ☐ Excavation/Gradi | |
| Utilities Siding Accessory Buildin | 그는 그 일이 많이 하면 가게 가는 아이는데 이번에 가는 아이를 하는데 하는데 하는데 하는데 하는데 되었다. |
| ☐ Landscaping ☐ Roofing ☐ Restoration/Repo | ir 🛘 In-kind Replacement 🔂 Demolition |
| Other: Solar Panel Installation | |
| ☑ Visible from public way | □ Not visible from public way |
| 4. FOR PROPERTIES UNDER EASEMENT FROM A HIS | STORTC PRESERVATION ORGANIZATION |
| Please provide written approval of request | |
| riease provide written approval of requesti | sa change from easement holder. |
| 5. WORK BEING PERFORMED BY: | |
| | |
| Architect or Engineer: Building Contractor: Power Factor - 8240 Beachwood Road | Baltimore Md. 21222 |
| Other: Electrician - George Lang - Same as Above | AND |

| 6. REQUIRED ATTACHI | MENTS TO THIS APPLICATION: | |
|------------------------------|--|---|
| ☐ Site Plan | ☐ Elevation | ☐ Detail Drawing(s) or Sketch(es) |
| ☐ Materials Sample(s) | ☐ Photographs (4x6 or larger) | ○ Other |
| (Please discuss appropriate | photographs/materials with Staff prior | r to application submission.) |
| | | (A) |
| 7. TAX CREDITS: | | |
| A. I plan to apply | for a Federal tax credit for this | s project: |
| | □ No | |
| B. I plan to apply | for a State tax credit for this | project: |
| □ Yes | □ No | 7. Tr |
| 9 T have applied for an | other Kent County named annual | al au license uccondina this nuccestre |
| | | al or license regarding this property: |
| 🗗 Yes | □ No | |
| SENTENDANCED BELEVENDE ANTON | | |
| | | neets as needed. Please provide information |
| on the teature, approxima | ate date of feature, existing condit | ion, and impact of proposed work.) |
| Install (44) rooftop mod | ules 17 60KW | |
| mistan (44) roomop mou | ales 17.00K W | |
| · | | |
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| | | |
| | | |
| 11 PLEASE READ AND | INITIAL THE FOLLOWING STA | TEMENTS: |
| | of this property, or | TEMEL VIOL |
| | [전하기 전기 [전 전 전 전 전 전 전 전 전 전 전 전 전 전 전 전 전 | calcad a latter from the amount of indication |
| | e of this application. | ached a letter from the owner(s) indicating |
| Their knowledg | e of this application. | |
| The information | n on this application represents an | accurate description of the proposed work. |
| I have omitted | nothing that might affect the deci | sion of the Historic Preservation |
| Commission. | | |
| I understand t | hat the approval of this application | by the Kent County Historic Preservation |
| Commission doe | es not constitute approval of other | required federal, state, or local permit |
| applications. | 7,25 | 100 |
| I agree to supp | ly two additional photographs of th | e appropriate representative views of the |
| | when the job is completed. | |
| I will attend (| or send a representative to attend) | the public hearing of this application before |
| | reservation Commission. | Paris |
| /6/) | | propriateness is not an authorization to |
| begin work. | | |
| // // | | |
| 16 50 | 05/02/2023 | |
| Signature of Applicant | Date | |
| | | |

CLERK OF CHARLES GOUNT

KENT GOUNT

2008 RUG 1 AM 9 35 Kent Caunty, Maryland LIBER 0 5 7 8 FOLIO 0 3 6

Historic Prescraation District Agreement

| For Official Use Only: DISTRICT FILE #: HPC - 08 - 001 | | 8 |
|---|------|------|
| This Historic Preservation District Agreement, fully signed, executed and dated 31 is between the County Commissioners of Kent County and | July | 2008 |

DOLLY E BAKER

Full Name(s) of Landowner(s) {please print}

- A. This agreement memorializes the understanding between the County Commissioners and the landowner that a historic preservation district shall be established on the land described below after it is executed by the landowner and is recorded in the land records of Kent County, Maryland.
- B. In signing this agreement, the landowner agrees that the following covenants, conditions and restrictions run with the land covered by this agreement.
 - The landowner recognizes that the district designation is perpetual and applies to subsequent owners of the property.
 - The landowner recognizes that the County has the right of enforcement in the event of demolition by neglect or other violations of the ordinance;
 - The landowner agrees not to divide the land for any purpose, including subdivision, off-conveyance and the adjustment of boundary lines, unless the Historic Preservation Commission first has provided written approval of the proposal;
 - 4) The landowner agrees not to construct additions, buildings or structures on the land or make exterior alterations unless the Historic Preservation Commission first has approved a Certificate of Appropriateness. However, nothing the ordinance shall be taken or construed to prevent maintenance that will have no material effect on the exterior fabric or features of a designated landmark, site, structure or district, or to prevent customary farming operations or landscaping that will have no material effect on the historic, archeological, or architectural significance of a designated landmark, site, structure or district.
- C. In consideration for agreeing to the covenants, conditions and restrictions set forth in Section B above, the landowner, with respect to the land covered by the agreement, may be eligible to receive tax credits for approved improvements.

The subject property contains 3/2 total acres, more or less as referenced below. The subject property is further described in the deed dated 15 3×2 and recorded among the Land Records of Kent County in liber 1×1 , folio 3×3 .

D. In signing this agreement, the landowner(s) hereby certify that the information contained herein is true and accurate to the best of their knowledge and hereby gives their permission to Kent County to record the district agreement in the land records.

Approved 3/27/07 return to: Caula Gorber, 400 High St. Chestertown

| Dally & Baker 1-31-08 | LIBER 0 5 7 8 FOLIO | 037 |
|--|---|---|
| Landowice Date | Landowner | Date |
| Landowner Date | Landowner | Date |
| Dary HMc Call 7-29-08 | Ry C. Cen | 7/29/08 Date |
| Chairman/Historic Preservation Commission Date | President, County Commissioners | Date |
| | | |
| State of Maryland, County of Kustt | , To Wit; | |
| - Ox | ^ | |
| I hereby certify that on this day of | | the subscriber, a |
| Notary Public in and for the State and County aforesaid, persona | illy appeared | |
| : Valle E. Daker | / | |
| known to me for satisfactorily proven to be the landowner(s) nar | med in the foregoing agreement and ackno- | wledged that they |
| executed the same for the purposes therein contained and, in my | presence signed and sealed the same. | |
| As Witness my hand and Notarial Seal | Was B. Finder | , |
| 15 | 11/00-1 | |
| 2.1. | Notary Public | |
| My Commission Expires: 9.1.08 | / | |
| My Commission Expires: 7.1.00 | | |
| DO NOT NOTARIZE FOR THE LA | NDOWNER BELOW THIS LINE | |
| | | |
| State of Maryland, County of | , To Wit; | |
| 1 | | |
| I hereby certify that on this day of | | the subscriber, a |
| Notary Public in and for the State and County aforesaid, persona | ally appeared () | 140.000 |
| Davy H. McCa | _[[| A -11 12 |
| known to me (or satisfactorily proven to be the Chairman of th | e Historic Preservation Commission of | Kent County) and |
| acknowledged that he/she executed the same in that capacity for | the purposes therein contained and, in my | presence, signed |
| and sealed the same. | | · ~ //~ |
| As Witness my hand and Notarial Seal | hard . Kou Man & | Town ? |
| 91 | Americal necession is | minora- 5 |
| | Notary Public | The same of the |
| My Commission Expires: 10-01-08 | | Contract of the second |
| My Commission Expires. 10 Or 04 | | *************************************** |
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| State of Maryland, County of Kont | , To Wit; | |
| 50 176 ON | 50 AND A | |
| I hereby certify that on this 29th day of | of July 2008, before me | the subscriber, a |
| Notary Public in and for the State and County aforesaid, person | ally appeared | |
| Commissioner Roy W. Ca | nu) | |
| known to me (or satisfactorily proven to be the President of the | County Commissioners of Kent County | y) and |
| acknowledged that he/she executed the same in that capacity for | the purposes therein contained and, in my | presence, signed |
| and sealed the same. | 73 (2 | E 5 |
| As Witness my hand and Notarial Seal | 0 . 1 1 - | |
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| | SNotary Public THE FOREGOIN | G AGMT FIL |
| M. Commission Business and Jose | FOR RECORD AND IS ACCORDI | NGLY RECORDED AMO |
| My Commission Expires: 101.108 | THE LAND RECORDS OF KENT | |
| | LIBER MLM NO.578 | OLIOS 36 -37 |
| | 1//// | . / // |
| Approved 3/27/07 | TVALR Z. THUS | ward, Cl |
| Approved 3/27/07 | | 1 |

Firefox about:blank

POWER FACTOR

Power Factor LLC 8240 Beachwood Road Baltimore, Md. 21222 Phone: (443) 559-0174 Fax: (443) 559-0178 www.powerfactorco.com

April 27, 2023

Kent County Maryland Historic Preservation Commission 400 High Street Chestertown, Md 21620

Re: Bonass Residence 11943 Augustine Herman Hwy Kennedyville, Md 21645 Solar Panel Installation

To whom it may concern,

I, Francis Bonass, hereby grant my permission to Power Factor to submit any necessary documents required to obtain approval for the install of (44) rooftop module solar system 17.6KW for the above residential location on my behalf.

Should you have any questions and/or concerns please feel free to contact me at 443-480-2933.

| Sincerely, | |
|----------------|--|
| Francis Benass | |
| Signature | |
| Francis Bonass | |
| Printed Name | |
| 5/2/2023 | |
| Date | |

www.powerfactorco.com

1 of 1 5/2/2023, 10:29 AM

DocuSign

Certificate Of Completion

Envelope Id: 5D8F34542A8849869A98BDC326717D50

Subject: Complete with DocuSign: Kent County Historic Preservation Owner Affidavit..pdf.pdf

Source Envelope:

Document Pages: 1 Signatures: 1
Certificate Pages: 4 Initials: 0

AutoNav: Enabled

Envelopeld Stamping: Enabled

Time Zone: (UTC-08:00) Pacific Time (US & Canada)

Status: Completed

Envelope Originator: Jessica Urban

8240 Beachwood Road Baltimore, MD 21222

customerservice@powerfactorco.com

IP Address: 73.213.150.170

Sent: 4/27/2023 7:50:38 AM

Record Tracking

Status: Original Holder: Jessica Urban Location: DocuSign

4/27/2023 7:48:44 AM customerservice@powerfactorco.com

Signature

Timestamp

Signer Events

Francis Bonass

Payment Events

Electronic Record and Signature Disclosure

fdbconstruction@gmail.com

Mr

Security Level: Email, Account Authentication

(None)

Francis Bonass

Signature Adoption: Pre-selected Style Using IP Address: 174.216.148.231

Signed using mobile

Status

Viewed: 5/2/2023 7:23:54 AM Signed: 5/2/2023 7:24:10 AM

Timestamps

Electronic Record and Signature Disclosure:

Accepted: 5/2/2023 7:23:54 AM

ID: eab9302f-fdcb-486d-8364-f6baef7e43f2

| In Person Signer Events | Signature | Timestamp |
|------------------------------|------------------|----------------------|
| Editor Delivery Events | Status | Timestamp |
| Agent Delivery Events | Status | Timestamp |
| Intermediary Delivery Events | Status | Timestamp |
| Certified Delivery Events | Status | Timestamp |
| Carbon Copy Events | Status | Timestamp |
| Witness Events | Signature | Timestamp |
| Notary Events | Signature | Timestamp |
| Envelope Summary Events | Status | Timestamps |
| Envelope Sent | Hashed/Encrypted | 4/27/2023 7:50:38 AM |
| Certified Delivered | Security Checked | 5/2/2023 7:23:54 AM |
| Signing Complete | Security Checked | 5/2/2023 7:24:10 AM |
| Completed | Security Checked | 5/2/2023 7:24:10 AM |

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If you decide to receive notices and disclosures from us electronically, you may at any time change your mind and tell us that thereafter you want to receive required notices and disclosures only in paper format. How you must inform us of your decision to receive future notices and disclosure in paper format and withdraw your consent to receive notices and disclosures electronically is described below.

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To advise Power Factor LLC of your new email address

To let us know of a change in your email address where we should send notices and disclosures electronically to you, you must send an email message to us at customerservice@powerfactorco.com and in the body of such request you must state: your previous email address, your new email address. We do not require any other information from you to change your email address.

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ii. send us an email to customerservice@powerfactorco.com and in the body of such request you must state your email, full name, mailing address, and telephone number. We do not need any other information from you to withdraw consent.. The consequences of your withdrawing consent for online documents will be that transactions may take a longer time to process..

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To confirm to us that you can access this information electronically, which will be similar to other electronic notices and disclosures that we will provide to you, please confirm that you have read this ERSD, and (i) that you are able to print on paper or electronically save this ERSD for your future reference and access; or (ii) that you are able to email this ERSD to an email address where you will be able to print on paper or save it for your future reference and access. Further, if you consent to receiving notices and disclosures exclusively in electronic format as described herein, then select the check-box next to 'I agree to use electronic records and signatures' before clicking 'CONTINUE' within the DocuSign system.

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- Until or unless you notify Power Factor LLC as described above, you consent to receive
 exclusively through electronic means all notices, disclosures, authorizations,
 acknowledgements, and other documents that are required to be provided or made
 available to you by Power Factor LLC during the course of your relationship with Power
 Factor LLC.

The County Commissioners of Kent County

ROY W. CROW PRESIDENT KENNEDYVILLE, MD

RONALD H. FITHIAN MEMBER ROCK HALL, MD

WILLIAM W. PICKRUM MEMBER CHESTERTOWN, MD R. Clayton Mitchell, Jr.
Kent County Government Center
400 High Street
Chestertown, Maryland 21620
TELEPHONE 410-778-7482
E-MAIL kentcounty@kentgov.org

SUSANNE HAYMAN COUNTY ADMINISTRATOR

JANICE F. FLETCHER EXECUTIVE ASSISTANT

THOMAS N. YEAGER COUNTY ATTORNEY

April 15, 2008

Ms. Dolly Baker 11154 Augustine Herman Highway Chestertown, MD 21620

> Re: Designation of a Local Historic Site John Kennedy House 11943 Augustine Herman Highway

Dear Ms. Baker:

The Board of County Commissioners held a hearing on April 8 to designate The John Kennedy House located on 11943 Augustine Herman Highway as a Historic Site and to list the property in the Kent County Register of Historic Places. Following written and oral testimony, the Board finds that the structure is historically significant. The Board based its decision on the following:

- Designation complies with the goals of the Comprehensive Plan to preserve the cultural, historical and archeological resources of Kent County.
- The structure is one of the oldest houses in Kennedyville and is associated with John Kennedy, founder of the village.
- The structure is one of two 3-story double brick houses in Kennedyville.
- The structure possesses distinctive architectural characteristics and reflects the influence of mid-19th Century Pennsylvania building techniques.

As a result of the April 8 hearing, we wish to designate The John Kennedy House as a Historic Site and list the property in the Kent County Register of Historic Places.

Very truly yours,

THE COUNTY COMMISSIONERS OF KENT COUNTY, MARYLAND

Roy W. Crow, President

Ronald H. Fithian, Member


William W. Pickrum, Member

KCC/smb

Cc Carla Gerber, Community Planner
Davy McCall, Chairman
Historic Preservation Commission

Recycled Paper



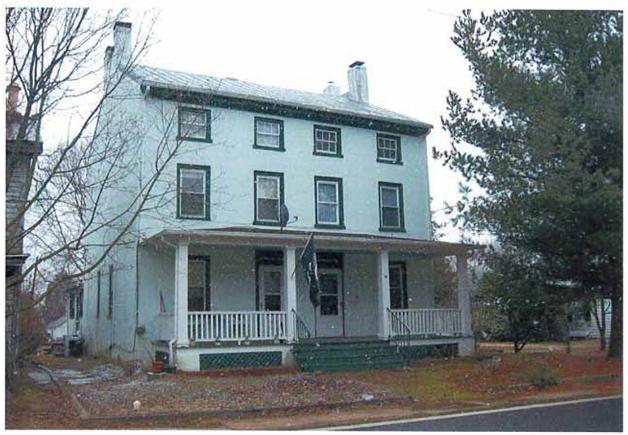







PHOTOVOLTAIC ROOF MOUNT SYSTEM

22 MODULES-ROOF MOUNTED - 8.800 kWDC. 7.678 kWAC 11943 AUGUSTINE HERMAN HWY, KENNEDYVILLE, MD 21645, USA

SYSTEM SUMMARY:

(N) 22 - HANWHA SOLAR Q.PEAK DUO BLK ML-G10+ 400 (400W) MODULES

THE CONTRACTOR/INSTALLER OF THE SOLAR PV SYSTEM OVER EXISTING ROOF SHALL

CONFORM TO OSHA REQUIREMENTS DURING THE CONSTRUCTION PHASE. JOB SAFETY

IN CASE OF CONFLICT BETWEEN STRUCTURAL DRAWINGS AND ELECTRICAL DRAWINGS,

THE CONTRACTOR/INSTALLER SHALL VERIFY ALL EXISTING BUILDING INFORMATION

SHOWN (DIMENSIONS, ROOF TOP PROJECTIONS, ETC.) AND NOTIFY THE ENGINEER OF

THE CONTRACTOR/INSTALLER SHALL VERIFY AND COORDINATE EXISTING OPENINGS,

ALL CONSTRUCTION IS TO BE PERFORMED IN STRICT CONFORMANCE WITH ALL APPLICABLE TOWN, COUNTY & STATE REGULATIONS AND/OR ANY OTHER GOVERNING DO NOT SCALE THESE DRAWINGS, USE DIMENSIONS. CONTRACTOR MUST CONDUCT ROOF SURVEY TO VERIFY DIMENSIONS SHOWN ON PLAN PRIOR TO INSTALLATION. IF THERE IS A DISCREPANCY IT IS CONTRACTOR/INSTALLER'S RESPONSIBILITY TO NOTIFY

ALL EQUIPMENT TO BE LISTED BY UL OR OTHER NRTL, AND LABELED FOR ITS APPLICATION.

WIRING, CONDUIT, AND RACEWAYS MOUNTED ON ROOFTOPS SHALL BE ROUTED DIRECTLY TO, AND LOCATED AS CLOSE AS POSSIBLE TO THE NEAREST RIDGE, HIP, OR VALLEY.

WORKING CLEARANCES AROUND ALL NEW AND EXISTING ELECTRICAL EQUIPMENT SHALL COMPLY

DRAWINGS INDICATE THE GENERAL ARRANGEMENT OF SYSTEMS. CONTRACTOR SHALL FURNISH ALL NECESSARY OUTLETS, SUPPORTS, FITTINGS AND ACCESSORIES TO FULFILL APPLICABLE

MODULE SUPPORT RAIL TO BE BONDED TO CONTINUOUS COPPER E.G.C. VIA WEEB LUG OR ILSCO

WHERE SIZES OF JUNCTION BOXES, RACEWAYS, AND CONDUITS ARE NOT SPECIFIED, THE

ALL WIRE TERMINATIONS SHALL BE APPROPRIATELY LABELED AND READILY VISIBLE. MODULE GROUNDING CLIPS TO BE INSTALLED BETWEEN MODULE FRAME AND MODULE SUPPORT

ALL CONDUCTORS SHALL BE COPPER, RATED FOR 600 V AND 90 & 75 DEGREE C WET

ROOF TOP UNITS, VENT PIPES, ETC. SHOWN ON DRAWINGS. IF THERE IS A DISCREPANCY BETWEEN DRAWINGS, IT IS THE CONTRACTORS/INSTALLER'S RESPONSIBILITY TO NOTIFY

AND CONSTRUCTION PROCEDURES ARE THE SOLE RESPONSIBILITY OF THE

REFER TO ELECTRICAL DRAWING PV-4 FOR PANEL DETAILED INFORMATION.

(N) 22 - ENPHASE ENERGY IQ8A-72-2-US MICRO-INVERTERS [240V]

(N) 01 - JUNCTION BOX

(E) 200A MAIN SERVICE PANEL WITH NO MAIN BREAKER

(E) 150A MAIN SERVICE DISCONNECT

(N) 60A FUSED AC DISCONNECT

(N) ENPHASE IQ COMBINER BOX 4

CONTRACTOR/INSTALLER.

THE ENGINEER IMMEDIATELY.

CODES AND STANDARDS.

GBL-4DBT LAY-IN LUG.

INTERCONNECTION METHOD: LINE SIDE TAP

THE MOST RIGID REQUIREMENTS SHALL GOVERN.

ENGINEER PRIOR TO PERFORMING THE WORK.

CONTRACTOR SHALL SIZE THEM ACCORDINGLY.

RAIL. PER THE GROUNDING CLIP MANUFACTURER'S INSTRUCTION.

THE POLARITY OF THE GROUNDED CONDUCTORS IS NEGATIVE

ANY DISCREPANCIES PRIOR TO INSTALLATIONS OF PV SYSTEM.

DESIGN CRITERIA:

ROOF TYPE: - ASPHALT SHINGLE NUMBER OF LAYERS: - 01 ROOF FRAME: - 2"X4" RAFTERS @ 24" O.C.

STORY: - TWO STORY SNOW LOAD: - 25 PSF WIND SPEED :- 112 MPH WIND EXPOSURE:- C RISK CATEGORY:- II

GOVERNING CODES:

2015 INTERNATIONAL BUILDING CODE (IBC) 2015 INTERNATIONAL RESIDENTIAL CODE (IRC) 2015 INTERNATIONAL MECHANICAL CODE (IMC)

2015 INTERNATIONAL FIRE CODE (IFC) 2014 NATIONAL ELECTRICAL CODE (NEC)

SHEET INDEX

P\/-0 COVER SHEET PV-1 SITE PLAN WITH ROOF PLAN PV-2 ROOF PLAN WITH MODULES

PV-3 ATTACHMENT DETAILS PV-4 ELECTRICAL LINE DIAGRAM WITH

CALCULATION

PV-5 PLACARD & WARNING LABELS **EQUIPMENT SPEC SHEETS**



DEL MAR, CA 92014, USA

DESIGN SUPPORT DAY OF INSTALL: CHAT.POWUR.COM

| VERSION | | | | | |
|-----------------|------------|-----|--|--|--|
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| INITIAL RELEASE | 01/11/2023 | UR | | | |
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PROJECT NAME

943 AUGUSTINE HERMAN HWY KENNEDYVILLE, MD 21645 USA FRANCIS BONASS 262348

UTILITY: DELMARVA POWER AHJ: KENT COUNTY APN# 1502003538

SHEET NAME

COVER SHEET

SHEET SIZE

ANSI B 11" X 17"


SHEET NUMBER PV-0


PROFESSIONAL CERTIFICATION, I HEREBY CERTIFY THAT THESE DOCUMENTS WERE PREPARED OR APPROVED BY ME, AND THAT AM A DULY LICENSED PROFESSIONAL ENGINEER UNDER THE LAWS OF THE STATE OF MARYLAND.

EXPIRATION DATE: 3/6/2023

STAMPED 02/01/2023



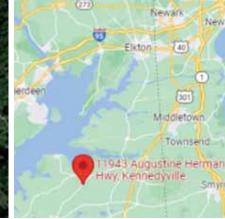

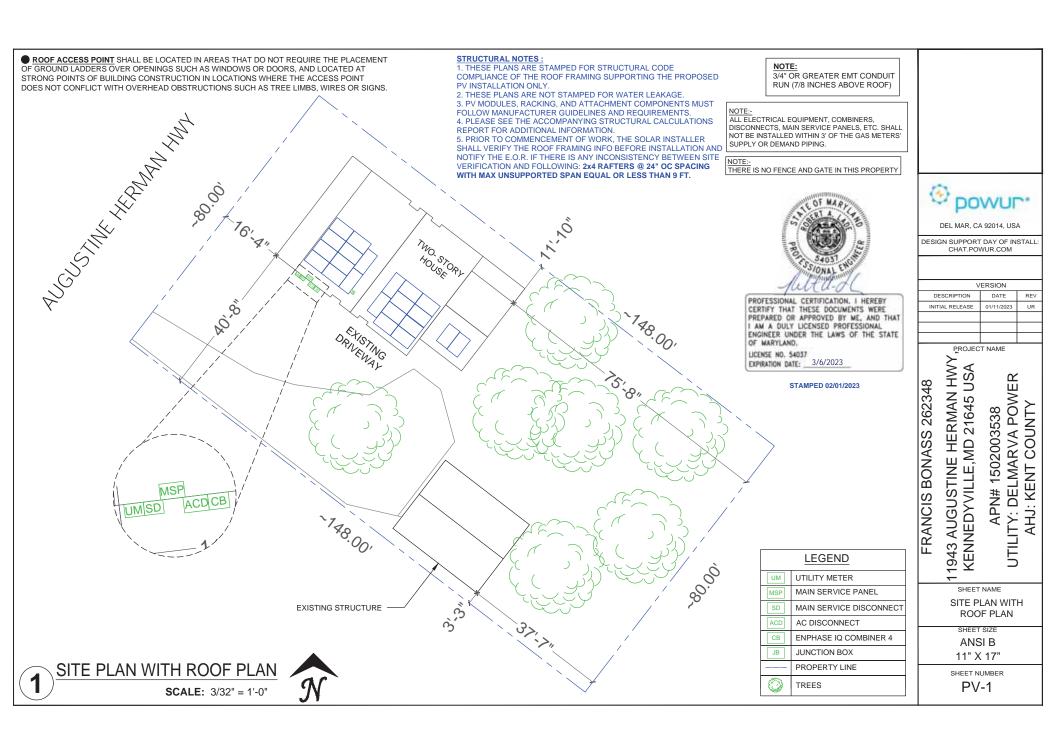

MODULE TY

NUMBER OF MO MODULE TYPE (400W) MODULE

MODULE WEIGH MODULE DIMEN UNIT WEIGHT OF ARRAY = 2.30 PSF

DISTRIBUTED DEAD LOAD = 2.57 PSF AVERAGE ROOF POINT DEAD LOAD = 21.37 LBS TOTAL SYSTEM WEIGHT: 1196.82 LBS

PHOTOVOLTAIC MODULES HANWHA SOLAR Q.PEAK DUO BLK ML-G10+ 400 (400W)

NOTE:

ATTACHMENTS

| YPE, DIMENSIONS & WEIGHT | ARRAY A | REA & ROOF ARE | A CALC'S |
|---|--------------------------------|---|-------------------------------------|
| IODULES = 22 MODULES E = HANWHA SOLAR Q.PEAK DUO BLK ML-G10+ 400 | AREA OF NEW ARRAY (Sq. Ft.) | AREA OF ROOF(PLAN VIEW) (Sq. Ft.) | TOTAL ROOF AREA COVERED BY ARRAY |
| ES | 464.66 | 1722.12 | 27% |
| GHT = 48.5 LBS / 22.0 KG. NSIONS = 74.0"X 41.1" = 21.12 SF | 27% | ROOF AREA (ARRAY < | 33% OF ROOF AREA) |
| | | | |

36° FIRE PATHWAY

NOTE: 3/4" OR GREATER EMT CONDUIT RUN (7/8 INCHES ABOVE ROOF)

| ARRAY AREA & ROOF AREA CALC'S | | | | | | | |
|--------------------------------|---|---------------------------------------|--|--|--|--|--|
| AREA OF NEW ARRAY (Sq. Ft.) | AREA OF ROOF(PLAN VIEW) (Sq. Ft.) | TOTAL ROOF AREA COVERED BY ARRAY % | | | | | |
| 464.66 | 1722.12 | 27% | | | | | |
| 27% | 27% ROOF AREA (ARRAY >33% OF ROOF AREA) | | | | | | |

| ARRAY AREA & ROOF AREA CALC'S | | | | | | | |
|-------------------------------|-----------------|----------------------------|---------------------------|---|--|--|--|
| ROOF | # OF MODULES | ARRAY AREA (Sq. Ft.) | ROOF AREA (Sq. Ft.) | ROOF AREA COVERED BY ARRAY (%) | | | |
| #1 | 10 | 211.21 | 570.76 | 37.00 | | | |
| #2 | 10 | 211.21 | 586.62 | 36.00 | | | |
| #3 | 2 | 42.24 | 149.91 | 28.18 | | | |

36 FIRE PATHINAN

| | ROOF DESCRIPTION | | | | | | |
|------|------------------|-------------------------|---------|-----------------|--------------------|--|--|
| | RO | ASPHALT SHINGLE ROOF | | | | | |
| ROOF | # OF MODULES | ROOF TILT | AZIMUTH | RAFTERS SIZE | RAFTERS SPACING | | |
| #1 | 10 | 26° | 308° | 2"x4" | 24" O.C. | | |
| #2 | 10 | 26° | 128° | 2"x4" | 24" O.C. | | |
| #3 | 02 | 10° | 218° | 2"x4" | 24" O.C. | | |

| BILL OF MATERIALS | | | | | | | | |
|-------------------|-----|------------------------------------|--|--|--|--|--|--|
| EQUIPMENT | QTY | DESCRIPTION | | | | | | |
| RAIL | 14 | UNIRAC SM LIGHT RAIL 168" MILL | | | | | | |
| SPLICE | 00 | BND SPLICE BAR PRO SERIES MILL | | | | | | |
| MID CLAMP | 30 | UNIVERSAL AF SERIES MID CLAMP | | | | | | |
| END CLAMP | 28 | UNIVERSAL AF SERIES END CLAMP | | | | | | |
| ATTACHMENT | 56 | UNIRAC FLASHLOC DUO ATTACHMENTS | | | | | | |
| GROUNDING LUG | 7 | GROUND LUG | | | | | | |

PROFESSIONAL CERTIFICATION, I HEREBY CERTIFY THAT THESE DOCUMENTS WERE PREPARED OR APPROVED BY ME, AND THAT I AM A DULY LICENSED PROFESSIONAL ENGINEER UNDER THE LAWS OF THE STATE OF MARYLAND.

LICENSE NO. 54037 EXPIRATION DATE: 3/6/2023

STAMPED 02/01/2023

| | LEGEND |
|-------------|--------------------------------------|
| UM | UTILITY METER |
| MSP | MAIN SERVICE PANEL |
| SD | MAIN SERVICE DISCONNECT |
| СВ | ENPHASE IQ COMBINER 4 |
| ACD | AC DISCONNECT |
| JB | JUNCTION BOX |
| | SM LIGHT RAIL |
| | MICRO-INVERTER |
| | ROOF ATTACHMENT @ 48" O.C. |
| 0 🗆 | VENT, ATTIC FAN (ROOFOBSTRUCTION) |
| \boxtimes | CHIMNEY |

| | 3:3,3:2,1 A 3:0,1 A 3: | THE |
|---|--|---|
| : ACTUAL ROOF CONDITIONS AND RAFTERS (OR SEAM) TIONS MAY VARY. INSTALL PER MANUFACTURER(S) I LATION GUIDELINES AND ENGINEERED SPANS FOR | 3:07 | |

14 Mills

Solution of the second of the

INSTALLATION GUIDELINES AND ENGINEERED SPANS FOR

ROOF PLAN WITH MODULES **SCALE:** 1/8" = 1'-0"





DEL MAR, CA 92014, USA

DESIGN SUPPORT DAY OF INSTALL: CHAT.POWUR.COM

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|-----------------|------------|-----|
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FRANCIS BONASS 2000 11943 AUGUSTINE HERMAN HWY, and a superviolet, MD 21645 USA 2000 11943 AUGUSTINE HERMAN HWY, and a superviolet MD 21645 USA 2000 11943 AUGUSTINE HERMAN HWY, and a supervi APN# 1502003538 UTILITY: DELMARVA POWER AHJ: KENT COUNTY

SHEET NAME **ROOF PLAN WITH** MODULES


SHEET SIZE ANSI B 11" X 17"

SHEET NUMBER

NOTE: ACTUAL ROOF CONDITIONS AND RAFTERS (OR SEAM) LOCATIONS MAY VARY. INSTALL PER MANUFACTURER(S) INSTALLATION GUIDELINES AND ENGINEERED SPANS FOR ATTACHMENTS

ATTACHMENT DETAIL

SCALE: NTS

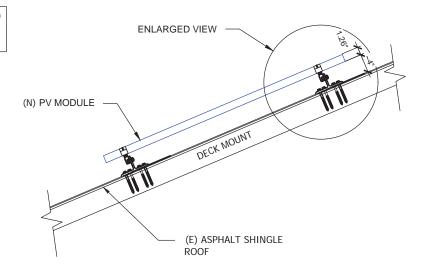

PROFESSIONAL CERTIFICATION, I HEREBY CERTIFY THAT THESE DOCUMENTS WERE PREPARED OR APPROVED BY ME, AND THAT I AM A DULY LICENSED PROFESSIONAL ENGINEER UNDER THE LAWS OF THE STATE OF MARYLAND.

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KENNEDYVILLE, MD 21645 USA TANACCE 11943 AUGUSTINE HERMAN HWY,
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KENNEDY TANACCE 11944 USA TANACCE 11944 AUGUSTINE HER UTILITY: DELMARVA POWER AHJ: KENT COUNTY

SHEET NAME

ATTACHMENT DETAIL

SHEET SIZE ANSI B 11" X 17"

SHEET NUMBER PV-3

MID CLAMP (N) PV MODULES SS SERRATED FLANGE NUT FLASHLOC DUO BASE MILL OR DARK BND T-BOLT & NUT 3/8X1 SS (E) ASPHALT SHINGLE ROOF / DECK MEMBRANE UNIRAC SM LIGHT RAIL **DECK MOUNT** 12-14 SCREW,(1/4" DAIMETER) HWH, SS, SELF-DR W/ #12 EPDM WASHER 1.5" MIN. **EMBEDMENT**

ATTACHMENT DETAIL (ENLARGED VIEW)

SCALE: NTS




| AMBIENT TEMPERTURE SPECIFICATIONS | | | | | | |
|-----------------------------------|--------------------------------|-------------------|---|--|--|--|
| RECORD LOW TEMP | AMBIENT TEMP (HIGH TEMP 2%) | CONDUIT HEIGHT | CONDUCTOR TEMPERATURE RATE (ON ROOF) | CONDUCTOR TEMPERATURE RATE (OFF ROOF) | | |
| -13° | 33° | 7/8 " | 90° | 75° | | |

| SOLAR MODULE SPECIFICATIONS | | | | | | | | | |
|---|---|-----------------------------|-------|-------|-----------|----|--|--|--|
| MANUFACTURER / MODEL # | JFACTURER / MODEL # VMP IMP VOC ISC TEMPERATURE COEFFICIENT OF Voc OF Voc | | | | | | | | |
| HANWHA SOLAR Q.PEAK DUO BLK ML-G10+ 400 (400W) | 37.13 | 10.77 | 45.30 | 11.14 | -0.27%/°C | 22 | | | |
| MODULE DIMENSION | | 74.0" L x 41.1" W x 1.26" D | | | | | | | |

SYSTEM SIZE:- 22 x 400W = 8.800 kWDC SYSTEM SIZE:- 22 x 349W = 7.678 kWAC

| INVERTER SPECIFICATIONS | | | | | | | |
|-----------------------------|----------|---------------------------|---------------------------|--|--|--|--|
| MANUFACTURER / MODEL # | QUANTITY | NOMINAL OUTPUT VOLTAGE | NOMINAL OUTPUT CURRENT | | | | |
| ENPHASE ENERGY IQ8A-72-2-US | 22 | 240 VAC | 1.45A | | | | |

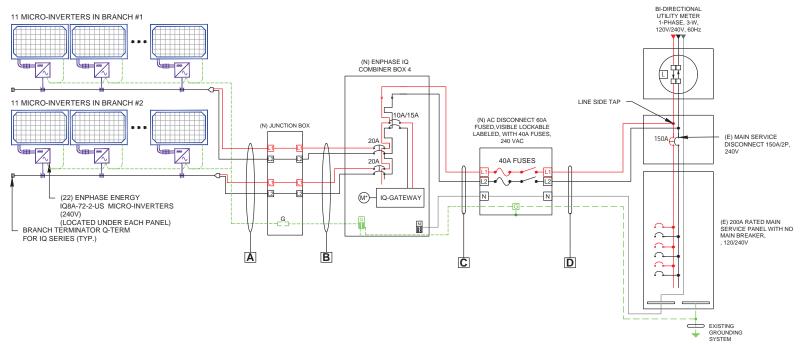

| WIRE TAG | CONDUIT | | IRE TY | WIRE (| GAUGE | W | IRE TYPE | TEMP. RATING | WI AMI TY | PACI | TEMP. DERATE | CONDUIT FILL DERATE | | ATED CITY (A) | INVERTER QTY. | DESIGN CURRENT (A) | GROUND SIZE | GROUND WIRE TYPE |
|----------|----------|---|-----------|-------------|--------|--------|-------------------------------------|-----------------|-----------------|------|-----------------|------------------------|-------|------------------|------------------|--------------------------|----------------|---------------------|
| А | OPEN AIR | | 2 | 12 <i>F</i> | AWG | Q | -CABLES | 90°C | 3 | 0 | 0.96 | 1.0 | 28 | .80 | 11 | 15.95 | 06 AWG | BARE CU GND |
| В | 3/4" EMT | 4 | 2 | 10 AWG | 12 AWG | THWN-2 | NM-B CABLES WHERE RUN INDOORS | 90°C | 40 | 30 | 0.96 | 0.8 | 30.72 | 23.04 | 11 | 15.95 | 10 AWG | THWN-2 |
| С | 3/4" EMT | | 3 | 8 A | WG | | THWN | 75°C | 5 | 0 | 0.94 | 1.0 | 47 | .00 | 22 | 31.90 | 10 AWG | THWN |
| D | 3/4" EMT | | 3 | 6 A | WG | THWN | | 75°C | 6 | 5 | 0.94 | 1.0 | 61 | .10 | 22 | 31.90 | 8 AWG | THWN |

ELECTRICAL LINE DIAGRAM WITH CALCULATION

SCALE: NTS



DEL MAR, CA 92014, USA

DESIGN SUPPORT DAY OF INSTALL: CHAT.POWUR.COM

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FRANCIS BOLLACO 11943 AUGUSTINE HERMAN HWY, KENNEDYVILLE, MD 21645 USA TANAN T APN# 1502003538 UTILITY: DELMARVA POWER AHJ: KENT COUNTY

SHEET NAME ELECTRICAL LINE DIAGRAM WITH CALCULATION SHEET SIZE

ANSI B 11" X 17"

SHEET NUMBER

WARNING

ELECTRIC SHOCK HAZARD DO NOT TOUCH TERMINALS

TERMINALS ON BOTH LINE AND LOAD SIDES MAY BE ENERGIZED IN THE OPEN POSITION

AC DISCONNECT, POINT OF INTERCONNECTION PER CODE: NEC 690.17(E)

WARNING: PHOTOVOLTAIC **POWER SOURCE**

LABEL LOCATION: CONDUIT, COMBINER BOX (PER CODE: NEC 690.31(G)(3)(4)

WARNING DUAL POWER SOURCE ECOND SOURCE IS PHOTOVOLTAIC SYSTEM

LABEL LOCATION: POINT OF INTERCONNECTION (PER CODE: NEC 705.12(D)(3) & NEC 690.64)

ADHESIVE FASTENED SIGNS:

- THE LABEL SHALL BE SUITABLE FOR THE ENVIRONMENT WHERE IT IS INSTALLED. (NEC 110.21(B)(3))
- WHERE REQUIRED ELSEWHERE IN THIS CODE, ALL FIELD APPLIED LABELS, WARNINGS, AND MARKINGS SHOULD COMPLY WITH ANSI Z535.4 [NEC 110.21(B) FIELD MARKING].
- ADHESIVE FASTENED SIGNS MAY BE ACCEPTABLE IF PROPERLY ADHERED, VINYL SIGNS SHALL BE WEATHER
- RESISTANT [IFC 605.11.1.3]

PHOTOVOLTAIC SYSTEM AC DISCONNECT RATED AC OPERATING CURRENT 31.90 AMPS AC NOMINAL OPERATING VOLTAGE 240 VOLTS

LABEL LOCATION: AC DISCONNECT, POINT OF INTERCONNECTION (PER CODE: NEC690.54 & NEC690.13(B))

WARNING INVERTER OUTPUT CONNECTION DO NOT RELOCATE THIS OVERCURRENT DEVICE

LABEL LOCATION: POINT OF INTERCONNECTION (PER CODE: NEC 705.12 (D)(2)(3b)) [Not required if panelboard is rated not less than sum of ampere ratings of all overcurrent devices supplying it]

SOLAR DISCONNECT

LABEL LOCATION:
DISCONNECT. POINT OF INTERCONNECTION (PER CODE: NEC690.13(B))

PHOTOVOLTAIC SYSTEM

EQUIPPED WITH

RAPID SHUTDOWN

LABEL LOCATION: UTILITY SERVICE ENTRANCE/METER, INVERTER/DC

LOCATIONS AS REQUIRED BY LOCAL AHJ.

MAIN PHOTOVOLTAIC

SYSTEM DISCONNECT


(PER CODE: NEC 690.13(B))

LABEL LOCATION:

DISCONNECT IF REQUIRED BY LOCAL AHJ, OR OTHER

PER CODE(S): NEC 2014: 690.56(C), IFC 2012: 605.11.1

MAIN SERVICE DISCONNECT / UTILITY METER

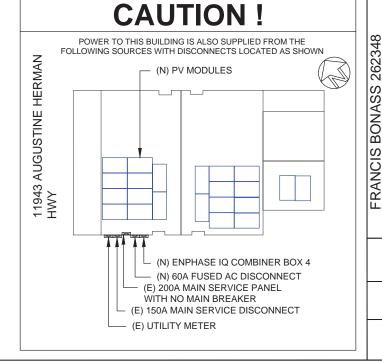

DEL MAR, CA 92014, USA

DESIGN SUPPORT DAY OF INSTALL: CHAT.POWUR.COM

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| | | |

PROJECT NAME

943 AUGUSTINE HERMAN HWY 21645 USA UTILITY: DELMARVA POWER AHJ: KENT COUNTY 1502003538 KENNEDYVILLE, MD APN#

SHEET NAME

WARNING LABELS & **PLACARD**

SHEET SIZE ANSI B 11" X 17"

SHEET NUMBER



low-light and temperature behavior



ENDURING HIGH PERFORMANCE

Long-term yield security with Are LID Technology, Anti-PID Technology¹, Hot-Spot Protect and Traceable Quality TracQ^{Ne}.



EXTREME WEATHER RATING

High-tech aluminum alloy frame, certified for high snow (5400 Ps) and wind loads (4000 Ps).



A RELIABLE INVESTMENT

Inclusive 25-year product warranty and 25-year linear performance warranty*.

1APT and conditions according to BC/15 BDBM 5.0005, matrices by CB00's BBM Place data affect on one for full flax information.


THE IDEAL SOLUTION FOR:

Engineered in Germany

QCELLS

MECHANICAL SPECIFICATION



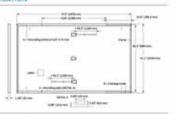


ELECTRICAL CHARACTERISTICS

| PO | WER CLASS | | | 368 | 390 | 209 | 400 | 406 |
|-----|--------------------------------|----------------------|-------------|---------------|-----------|---------|--------|----------------|
| 197 | VIMILIAN PERFORMANCE AT STANDA | ACCUSATION CONTINUES | NE TIC IN | WESTOLDANCE - | EWIT-CWI. | 7,5,000 | | |
| | Power of MED | Fare | [W] | 365 | . 100 | 315 | 400 | 400 |
| | Stort Dropt Darwer | - 64 | 100 | 11.04 | 11.07 | 31.10 | 13.14 | 13.17 49.34 |
| ŀ | Store Strutt Voltage* | , V _m | [9] | 40.18 | 45.23 | 49.27 | 45.30 | 45.34 |
| 1 | Current of MVP | 400 | 181 | 30.09 | THE | 10.71 | 1077 | 311.03 |
| - | Virtings of MPF | Veri | . Nr. | 3636 | 36.62 | 26.86 | 37.13 | 37,24 |
| | ETTioners of | | . (%) | 1100 | 119.0 | 1201 | +20.4 | +204 |
| ij | WALLEY PERFORMANCE AT NORMA | LOPERATIVE COND | D HOYS, MND | p#+ | | | 110.00 | |
| | Franciscop SCHER | Plant | 240 | 296.6 | 292.0 | 296.3 | 3001 | 303.8 |
| t | Shart Cored Cored | L. | - 441 | 8.90 | 8.92 | 8.45 | 6.97 | 9-00 |
| ŀ. | Since Desoit Voltage | V _m | . po. | 40.62 | 42.65 | 4189 | 4277 | 42.76 |
| 5 | Control of Self- | - 1- | 144 | 8.35 | 8.41 | 3.40 | 8.51 | 1657 |
| | Markey or Ballet | - 2 | 100 | 14.00 | the day | 26.04 | 36.74 | 100 400 |

O CELLS PERFORMANCE WARRANTY

ex. Full sementes in accordance will the sementy terms of the IQCBLLS.

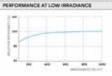

| EMPERATURE COEFFICIENTS | | | | | | | | |
|---|-----|--------|-------|-------------------------|---------------------|-------|-------|----------------|
| Sergerature Coefficient of h _t | - 1 | (9.00) | -0.04 | Teinmelature Confficier | mat V _{ec} | | (9/4) | -0.27 |
| Retranslated Disefficient of Page | | 1814) | -0.34 | Hummer Medical & Comm | my Temperature | MAIDE | 215 | 226+54(83+2*C) |

PROPERTIES FOR SYSTEM DESIGN

| Marriago System Vallego Vac- | M | \$200 (FIC)/\$200 (AA) | Pythodule constitution | Cast |
|---------------------------------|--------|------------------------|-------------------------------------|---------------------|
| Macroure Saries Fung Balley | (A DC) | 30 | Fire fining based on AMSL/17L RST00 | TYPE 2 |
| Mail Design Load, Push / Pull* | | | | HCF-up to 1225 F. |
| Man. Tool Lovel, Protect Public | Jha/95 | 111(5400Pe) 94(4000Pe) | on Curtinuous Duty | (-40°C-46.10 +85°C) |

QUALIFICATIONS AND CERTIFICATES

PACKAGING INFORMATION





| | 0 | .0 | 0 | Ö | 20 | | |
|-------------|--------|--------|--------|---------|---------|--------|--------|
| reseasers's | 76.6± | 43.3m | 49.0± | 2656 bu | 24 | 24 | nod/ee |
| packaging | 1940±= | 1100mm | 1230== | 752 kg | patient | pelate | |

Note: including national next by follower. See the residence and questing menue or contact our highest service paperment by highest elements or approximate residence and questions.

Sensite & CELLS Americanics.

400 Sensitive Connections. State \$400, Survey, CA SCREE, USA 1991, of SHE NR SERVE (MAKE, report State Conference) WEST were greatly as



DEL MAR, CA 92014, USA

DESIGN SUPPORT DAY OF INSTALL: CHAT.POWUR.COM

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| DESCRIPTION | DATE | REV | | |
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PROJECT NAME 1943 AUGUSTINE HERMAN HWY KENNEDYVILLE,MD 21645 USA FRANCIS BONASS 262348

APN# 1502003538 UTILITY: DELMARVA POWER AHJ: KENT COUNTY

SHEET NAME

SPEC SHEETS

SHEET SIZE ANSI B 11" X 17"

SHEET NUMBER







IQ8M and IQ8A Microinverters

Our newest IGB Microinverters are the industry's first microgrid-forming, software defined microinverters with split-phase power conversion capability to convert DC power to AC power efficiently. The brain of the semiconductor-based microinverter is our proprietary application specific integrated circuit (ASIC) which enables the microinverter to operate in grid-tied or off-grid modes. This chip is built in advanced 55nm technology with high speed digital logic and has superfast response times to changing loads and grid events, alleviating constraints on battery string for home energy systems.



Part of the Enghase Energy System, KSB Series Microinverters integrate with the IQ Battery, IQ Gateway, and the Enghane App monitoring and analysis software.



Connect PV modules mackly and easily to IQ8 Series Microinverters using the included Q-DCC-2 adapter cable with plug-n-play MC4 connectors.



IQB Series Microinverters are UL listed as PV Rapid Shutdown Equipment and conform with various regulations, when installed according to manufacturer's instructions.

KQB Series Microleverturs redefine

reliability standards with more than one-

million cumulative hours of power-on.

"Crity when notated with ID System Curpolier II, marts IB, 1745 "Colle and ESA support got phase, 34 N establishes rety

6 2007 Enghand Energy, Af rights manned. Enghana, the Enghana Logo, KSA SAkriannerlans, and other harnes are trademarks of Enghana Energy, Inc. Data subject to Jourge.

Easy to install

- Lightweight and compact with plug-mplay connectors.
- Power Line Communication (PLC) between components
- Faster installation with simple two-wire cableg

High productivity and reliability

- . Produce power even when the grid is
- More than one million cumulative hours of testing.
- · Class II double-wallsted enclosure
- · Optimized for the latest high-powered PV modules

Microgrid-forming

- . Compiles with the latest advanced grid
- Remote automatic updates for the latest grid requirements
- Configurable to support a wide range. of grid profiles
- Meets CA Rule 21 (UL 1745-SA) and IEEE 1547:2018 O.H. 1741-580

provious generations of Disphase Historiverbers (ICE)* barries, ICE Serves, etc.) in the same system.

KIRAN CA-DE-0009-02-09-19-3023-03-02

IQ8M and IQ8A Microinverters

| HAPOT BATA (BID) | | 1944-22-3-49 | 1084-70-0-08 |
|---|-----|---|--|
| Comments used module purings ² | W | 260 - 460 | 295 - 500 |
| Module comparisity | | 54-oil / 108 half-cell, 60-cell / 50 half-cell, 66-ce | f / 132 half-cell and 72-cell / 144 half-cell |
| MFTT voltage range | . 8 | 30 - 40 | 33 - 43 |
| Operating range | | 16 - 56 | |
| Mirt. / Max. start voltage | - 9 | 22 / 58 | |
| Max. Irgin/IDC voltage | W | 40 | |
| Max. continuous input DC current | A. | ti ti | |
| Max. injust DC short-pirout ourrent | . A | | |
| Max. reidale (_ | A | 20 | |
| Overvoltage class DC port | | F. | |
| DC port backhed current | 9.6 | 0 | |
| Miles and the section | | | All tale and a decision of the State of |

| FV array configuration | | Ingrounded array. No additional DC side protection: | required. AC side protection requires may 20A per transh strout |
|--|-------------------|---|---|
| BUTFUT DATA (AC) | | 104H-17-2-10 | 1984/20-0-08 |
| Presi output power | 96 | 330 | 366 |
| Mee, continuous output jermet | 94. | 305 | 349 |
| Nominal IL-L1 voltage / range? | 9 | 340 | /28-264 |
| Max continuous output current | | 130 | 145 |
| Noninal Impancy | - 10 | | 60 |
| Extended frequency range | 60 | | 47 - 68 |
| AC short smout fault oursett over 3 cycles | Arm | | * |
| Max units per 20 A IL-Li branch caro | sale ⁴ | | T . |
| Total hermonic detortion | | | 45% |
| Overwittige class AC port | | | |
| AC port backfeed current | 166 | | 30 |
| Power Scitor setting | | | 10 |
| Grid-Sed power factor (adjustable) | | 0.80 lead | ng - 0.85 legging |
| Feat efficiency | 19.1 | sta . | 923 |
| CEC weighted efficiency | | 97.5 | 97 |
| Night-time bioset surrounding. | 400 | | 60 |

| Night-time power consumption will | 80 |
|--|--|
| RECOMMENT DATA | |
| Antient temperature range | -40°C to -80°C (-40°F to -140°F) |
| Belative humidity range | 4% to 100% Stondening) |
| DC Connector type | MC4 |
| Dimensions (H x W a D) | 212 mm (8.3") x 175 mm (8.6") x 30.2 mm (8.2") |
| Weight | 1.08 kg (2.36 ba) |
| Cooling | Natural connection – no fans |
| Approved for set locations | No. |
| Poliuliza degree | PO3 |
| Dictoure | Date Educate-Insulated, compaler resistant polymeric enclosure |
| Styleon, category / UV exposure rating | NEMA Type & / mutition |

CARLO 218. SALE, 1915 SALE, 62105-1, REE 1547209 BA. 1781-98. FCC Part 15 Class B. ICES-0003 Class B. CAN / CSA-C22.2 MD. 1071-01 This product is UL Lated as PV Rapid Shutcherr Egyphaent and conforms with NEC 2014, NEC 2017, and NEC 2020 section 69032 and 2018 Rapid Shutcherr of PV Systems, for AC and DC conductors, when installed according to manufacturer's instructions. with NEC 2014, NEC 2017, and NEC 2020 section 69032 and C223-

If having PV modules of heart agreedows the first may reput in exhibitant objecting boses. See the compatibility solutions of these PV compatibility of administration of the explanation for the extra large entry to extend the control of the extra large entry to extend the extra large entry to extra large entry entry

\$3866 \$24.00 0000 \$2.60 LB \$000 \$2.00



DEL MAR, CA 92014, USA

DESIGN SUPPORT DAY OF INSTALL: CHAT.POWUR.COM

| VERSION | | | | |
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| DESCRIPTION | DATE | REV | | |
| INITIAL RELEASE | 01/11/2023 | UR | | |
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PROJECT NAME

1943 AUGUSTINE HERMAN HWY. KENNEDYVILLE,MD 21645 USA APN# 1502003538 UTILITY: DELMARVA POWER AHJ: KENT COUNTY

FRANCIS BONASS 262348

SHEET NAME

SPEC SHEETS

SHEET SIZE ANSI B 11" X 17"

SHEET NUMBER

Clata Sheet Enphase Networking

Enphase IQ Combiner 4/4C

X-IQ-AM1-240-4 X-IQ-AM1-240-4C



The Enghane IQ Combiner 4/4C with Enphase IQ Gateway and integrated LTE-M1 cell modern (included only with IQ Combiner 4C) consolidates interconnection equipment into a single enclosure and streamlines IQ microinverters and storage installations by providing a consistent, pre-wired solution for residential applications. It offers up to four 2-pole input circuits and Enton BR series busbar assembly.

Smart

- · Includes IQ Gateway for communication and control
- · Includes Erphase Mobile Connect cellular modern. (CELLMODEM-M1 -06-SP-05), included only with IQ Combiner 4C
- · Includes solar shield to match Enghase IQ Battery sesthetics and deflect heat
- · Flexible networking supports Wi-Fit. Ethernet, or cellular
- · Optional AC receptacle available for PLC bridge
- · Provides production metering and consumption monitoring

Simple

- · Centered mounting brackets support single stud minuriting
- · Supports bottom, back and side conduit entry
- Up to four 2-pole branch circuits for 240 VAC plug in breakers (not included).
- · BOA total PV or storage branch circuits

Reliable

- · Durable NRTL-sentified NEMA type 3R enclosure
- · Five-year limited warranty
- Two years labor reimbursement program coverage included for both the IQ Combiner SKU's
- · UL listed



Enphase IO Combiner 4/4C

| MODEL NUMBER | |
|--|--|
| IO Concurse d (RIIQ-AMT-346-4) | CC Conducted 4 with Englasse IS Currency protest contact based for edge stand revenue grade PV production makeing (AAS CCLS IV + 0.5%) and consumption mandaturing (A-2.5%). Includes a silver order advantation immediate IV grade in definit from a |
| 10 Combiner 9C (9-10 AMT (943-4C) | C) Combiner 4C with Exphase 3C dishway primed shout board for integrated investigating the PV production metaling (ARS CE230 × 8.9%) and consumption insenting prin 2.0%, includes Exphase Motive Connect self-lat motions. CCLLMCCOM AN OLE-PCII, page and pay enduring yellow and resident in application and prime as of 60 transmission. (Assistable in the UE, Carasia, Marcia, Paris I Ros, and the UE Vage faileds, aftern there is alregate self-late among the institution and includes and the control and of the control and only includes and the resident hand to make the CE Carasia. |
| ACCESSORIES AND REPLACEMENT PARTS | (not included, ordet separately) |
| Triserdis Communications EX COMMIS CELLINCOLM MIT IN COLLINCOLM MIT IN IP III CELLINCOLM MIT IN IT IS | - Includes COMMS 477-01 and CELLMOORN M1-06-97-05 with 5-year Sprint data plan for Examinate value - 4-00 selector modern with 5-year Sprint data plan - 40 sawed CTE-M1 cellular markets with 5-year Sprint data plan - 40 sawed CTE-M1 cellular markets with 5-year 4767 data plan |
| Const Bealers BH 03A 2-940/ BH 03A 2-940/ BH 03A 29-340/ BH 03A 29-340/ BH 03A 27-340/ BH 03A 27 | Suggest Ealan (RCT), RR215, RR226, RR226, RR236, and RR236, and RR236 or continues Cross travelse 2 page, Na, Faster (RCS). Cross travelse 2 page, 154, Ealan (RCS). |
| MPLC-01 | Power fire same pomouncation bridge past, quantity - one past |
| KA-SOLARSHIELD-EE | Replacement asile stretch for IQ Combiner 4/40 |
| 8A PLUG 125 8 | Accessivy receptable for Power Line Current ACC Complete 4-90 (required for EPAC 8Y) |
| KA-UNY-PCBA-E | Replacement ID Getweey protect cross tinant (PCB) for Commer A.MC |
| KIQ NA HQ 125A | Hold strian AX for Easter project breaker with somew |
| ELECTRICAL SPECIFICATIONS | |
| Rainy . | Continuos Arty |
| System soltage | \$28240 NAC 66 Hz |
| Early III serves bust or naving | 191A |
| Miss continuous current sarray | 68.A |
| Mue continuous current rating Equal hiers Philosopoli | 64A |
| Max Turniterout rating (initput) | WA |
| Branch chours (sens and/or storage) | Up to face 2 year Exten BH serves Distributed Generation (DC) breakers only (set included) |
| Max. total transh circuit treater rating (rquit) | 85A of distributed generation / MA with IQ Galaxing tension included |
| Production matering CT | 200 A send core pre-histolied and elect to IQ Cateries |
| Consumption mustaring CT (CT-350 SPLIT) | A pair of 200 A split core correct transformers |
| MECHANICAL DATA | |
| Demonstruct (WeiteD) | 315+465+163 pm (IA77's 163's 667) Height is 2130' (63.5 pm) with mounting breshalls. |
| Weight | 71kg (% 5 ks) |
| Action Improvement | 42°C to +40°C (40°to 318°F) |
| Challeg | Natural convention, plus final shreld |
| Drubman minumental rating | Queboo NRTs certified, NEMA type 3R pelycarbonate construction: |
| Why alles | 20. A to SSA himselson impacts. 14 to 4.469CS compare contributions. 60. A himselson behavior himsels in 501,449CS compare considerations. Mass large contributed society. 10 to 2:0 ANNO progress considerations. Meastral and grownich 14 to 1.01 compare considerations. Meastral and grownich 14 to 1.01 compare considerations. Alexange in Alliens and cold code registerations of particular society. |
| ANNUM | 3u 2000 meters (6.560 feet) |
| INTERNET CONNECTION OPTIONS | |
| Integrated NO. Fo | MEINGS |
| Celtular | CELLINCOLM AN ON-OP-DIS, CELLINCOLM AN OA AT DE VICE based CTE ARE celture mediants. Note that an Enghant Mubble Consect cellular residence to segment for all Ensemble cellulations. |
| Otensi | Optional BC2.3. CarSE (or Car NEVTP Ethernal cable drut included) |
| COMPLIANCE | |
| Directaine, 10 Container | ALT 1911, CAMPER AZZU No. 1927, 42 CFR, Pert 19, Clear B. MES 009 Production manning ANSI ETZ 20 annursing states B. 5 (PV production) Consumption making accuracy states 2.5 |
| Compliance, IQ Canness | UL S/BES 1/CANCSA 22 2 No. 61610-1 |

To learn more about Enphase offerings, visit enphase.com

© 2021 Exphase Every). At lights sowned. Brohase the Exphase top), 3) Contains AVIII, and other names are treatments of Surhead Every). No Cells adjust its change. 10-21-2021.





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|-----------------|------------|-----|
| DESCRIPTION | DATE | REV |
| INITIAL RELEASE | 01/11/2023 | UR |
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FRANCIS BOINAGO - 11943 AUGUSTINE HERMAN HWY,
KENNEDYVILLE, MD 21645 USA
TOTAL STATE AUGUSTINE HERMAN HWY,
T APN# 1502003538 UTILITY: DELMARVA POWER AHJ: KENT COUNTY


SHEET NAME

SPEC SHEETS

SHEET SIZE ANSI B 11" X 17"

SHEET NUMBER PV-8

To learn more about Enghase offerings, visit enghase.com

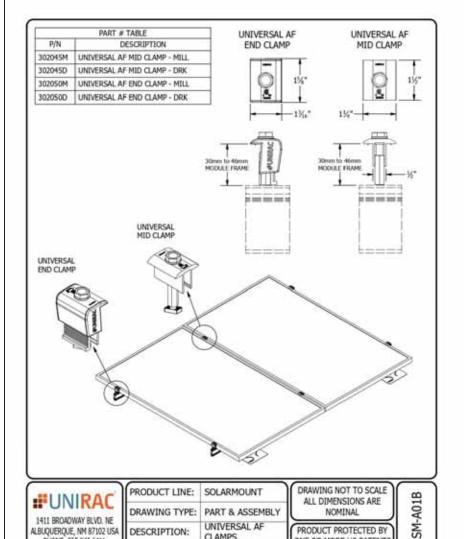

UNIVERSAL AF

CLAMPS

DESCRIPTION:

REVISION DATE: 9/28/2020

PRODUCT PROTECTED BY

ONE OR MORE US PATENTS


LEGAL NOTICE

SHEET

ALBUQUERQUE, NM 87102 USA

PHONE: 505.242.6411

WWW.UNTRAC.COM

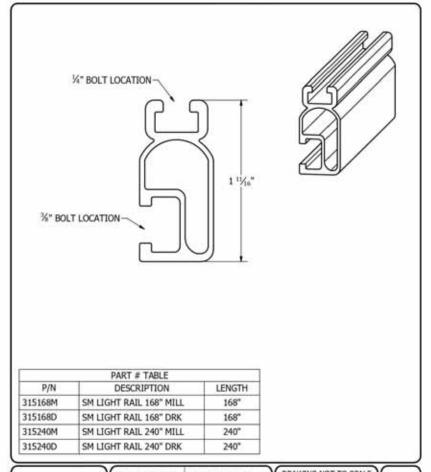

| 315240M | SM LIG | HT RAIL 240' |
|---------|--------|--------------|
| 315240D | SM LIG | HT RAIL 240 |
| | | |
| | DAC. | PRODUCT L |

| | PRODUCT |
|--|----------|
| 1411 BROADWAY BLVD. NE | DRAWING |
| ALBUQUERQUE, NM 87102 USA PHONE: 505.242.6411 | DESCRIPT |
| WWW.UNIRAC.COM | REVISION |
| | |

| RODUCT LINE: | SOLARMOUNT | |
|----------------|-------------|--|
| RAWING TYPE: | PART DETAIL | |
| ESCRIPTION: | LIGHT RAIL | |
| REVISION DATE: | 9/11/2017 | |

DRAWING NOT TO SCALE ALL DIMENSIONS ARE NOMINAL

PRODUCT PROTECTED BY ONE OR MORE US PATENTS LEGAL NOTICE

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DEL MAR, CA 92014, USA DESIGN SUPPORT DAY OF INSTALL: CHAT.POWUR.COM VERSION DATE DESCRIPTION

INITIAL RELEASE

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FRANCIS BONACCE 11943 AUGUSTINE HERMAN HWY,
KENNEDYVILLE, MD 21645 USA LOCATION TO STATE THE MANNEDY STATE TO STATE THE MANNED STATE TO STATE THE MANNED STATE TO STA APN# 1502003538 UTILITY: DELMARVA POWER AHJ: KENT COUNTY

SHEET NAME

SPEC SHEETS

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SHEET NUMBER PV-9

FLASHLOC™ DUO



FLASHLOC™ DUO is the most versatile direct to deck and rafter attachment for composition shingle and relied comp roofs. The all-in-one mount installs fast - no kneeling on hot roofs to install flashing, no prying or cutting shingles, no pulling nails. Simply drive the required number of screws to secure the mount and inject sealant into the base. FLASHLOC's patented TRIPLE SEAL technology preserves the roof and protects the penetration with a permanent pressure seal. Kitted with two rafter screws, sealant and hardware for maximum convenience (deck screws sold separately). Don't just divert water, LOC it out!





PROTECT THE ROOF

Install a high-strength voterpoor attachment without lifting, prying or damaging stoughts.

APREZET FLASHCOCOLO VIZ



LOC OUT WATER

With an actor shield 10 systems conflavoing gashet. Simply drive the required number of screen and might 10 and personnell scalard chamber 10 the high East 1 realized into the per 10 to create a personnell property. industry diliters a IOTs extension connection.



HIGH-SPEED INSTALL

FLASHLOC™ DUO





PRE-INSTALL: CLEAN SURFACE AND MARK LOCATION

Ensure existing reof structure is capable of supporting loads prescribed in Flashico Due D&E Guide. Clean reof surface of dirt, debris, snow and ice.

Snap chalk lines for attachment rows. On shingle roofs, snap lines 1/4" below upslope edge of shingle coarse. This line will be used to align the upper edge of the mount.

NOTE: Space mounts per span charts found in FLASHLOC DUD state certification letters.

STEP ONE: SECURE



ATTACHING TO SHEATHING: Place FLASHLOC DUO over desired location and align upper edge of mount with harizontal chalk line. Secure mount with the two (2) provided rafter screws. Next, secure mount with four (4) deck screws by drilling through the FLASHLOC DUO deck mount hale locations. Unitac recommends using a drill as opposed to an impact gun to prevent over-tightening or stripping roof sheathing.


IMPORTANT: SECURELY ATTACH MOUNT BUT DO NOT OVERTIGHTEN SCREWS.



STEP TWO: SEAL

insert tip of UNIRAC approved sealant into port and inject until sealant exits yent. Continue array installation, attaching rails to mounts with provided 1-bolts. Follow sealant manufacturer's instructions. Fellow scalars manufacturer's cold weather application guidelines, if applicable.

NOTE: When FLASHLOC DUO is installed over gap between stringle tals or vertical joints, fill gop/joint. with sealant between mount and upslope edge of shingle course.

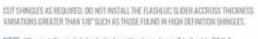

NOTE: When installing included rail attachment hardware, torque T-bolt mut to 30 ft-lbs. NOTE: If an exploratory hole falls outside of the area covered by the sealant, flash hole accordingly. NOTE: Read and comply with the Flashlor: Duo Design & Engineering Guide prior to design and imballation of the system.

USE ONLY UNIFICE APPROVED SEALANTS. PLEASE CONTACT UNIFICE FOR FULL UST OF COMPATIBLE.



SEALANTS.

FASTER INSTALLATION. 25-YEAR WARRANTY.

FOR QUESTIONS OR CUSTOMER SERVICE VISIT UNIRAC COM OR CALL (505) 248-2702

FASTER INSTALLATION. 25-YEAR WARRANTY.

FOR DUESTIONS OR CUSTOMER SERVICE VISIT UNIRAC COM OR CALL 15051 248-2702

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PROJECT NAME

1943 AUGUSTINE HERMAN HWY KENNEDYVILLE,MD 21645 USA UTILITY: DELMARVA POWER AHJ: KENT COUNTY

FRANCIS BONASS 262348

SHEET NAME

SPEC SHEETS

SHEET SIZE ANSI B 11" X 17"

SHEET NUMBER



CODE COMPLIANCE NOTES

This space for class sering requires installation in the menner specified in the SOLARMOUNT installation Guide. SOLARMOUNT has been (lessified to the system level, the portion of ULTOS, SOLARMOUNT has absent (level the portion of ULTOS, SOLARMOUNT has absent (level the portion of ULTOS, SOLARMOUNT has absent level the portion of ULTOS, SOLARMOUNT has absent level the performance for steep slopes of ook. The first classification retrieved system may be present the 2.15 judges 9.2 increases per foot, or 9.5 degrees, The system in ta be mounted over for restorator roof covering sets for the application. These is no required distriction or maximum height desidation above the roof deck to maintain the system fire rating for SOLARMOUNT Melable Types, System Level Fire Ratings, and Misgations Rapiciaments are listed below.

| Rall Spe | Hodule Fire Types | System Level Fire Batting | Rail Direction | Phodole Orientation | Mitigation Required |
|--|--|----------------------------|----------------|------------------------|------------------------------|
| Species & HO Build | 2. 5. 9 with Help Trans, 10 with Their | (San A. Clarch A. Clarc C. | East West | Unitage CR Pythill: | Nové Repárezi |
| | Nova 58.1E (5.19.A 10 | | North South | Landscape CR Plateds | Note Reported |
| Flight Kell | 14.7 | Clare A, Clare B & Clare C | East West | Carolicage DR Pertrait | Non-Regulant |
| COLUMN TO SERVICE STATE OF THE | | | North South | Landscape DR Person | Now Required |
| Toerstant Light, 6 | 181 | Then A, Clarc B & Clarc C | Typ Blue. | Landrage SR Partiell | Tries restablished per Solar |
| HTRES | | | Markin South | Landouge DE Perholi | House Indefed on facile |

The racking aption may be used to ground and/or record a PV recoker complying with ULEYES or ULESTS any when the apartle controls has be


ULTER CERTIFICATION MARKING LABOR.

Notes SQLARMONT is listed to U.C. 705. Certification marking is embossed on all mid clamps as shown. Labels with additional information will be provided. After the recking system is fully assembled, a single label should be applied to the SQLARMONIST mil at the edge of the array, Befare applying the label, the convers of the label that do not perials to the system being installed must be revenued so that only the installed system type is sheeing.





STANDARD SYSTEM GROUNDING

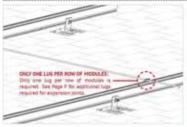

EROUNDING LUG MOUNTING DETAILS: Details are provided for both the WEER and face products. The WEERLug has a

grounding symbol located on the lug assembly. The Ilison lug has a green colored set screw for grounding indication purposes, installation must be in accordance with NFPA NEC 70, however the electrical designer of record should refer to the latest revision of NEC for actual grounding conductor cable size.

STATUTED A STATEMENT OF THE PARTY OF BOLT SIZE

#10-32 Torque value deparets on conductor size See product data sheet for torque value.

WEEBLug

TISCO LVE



Apply Anti Seige and insert a bolt in the auminum rail and through the clearance hole in the standard other flat weather. Place the standard steel flat weather on the bod, oriented on the directes will context the aluminum reli. Place the log portion on the bolt and stainless steel flat washer, install stainless steel flat washer, lock washer and nut. Tighten the nut until the dimples are completely entended into the rail and lug.





RLSCO LAY-IN LUG CONDUCTOR - UNIFIAC P/M 008009P; Alternate Grounding Lug DIEL debut hole and bott thru both reil wells per table.

UNIVERSAL AF ENDCLAMP INSTALLATION GUIDE : PAGE



BONDING CONNECTION GROUND PATHS





BONDING MIDCLAMP ASSEMBLY BONDING HID CLAMP ASSEMBLY

- discretion trid clarge with equities other booding pins that pinns module frame anadization to bond motivie to median through clamp.
- A transported and book algorithm carry to exprise and I but
- * Toropad 1 deal hand presentation rail are distributed to bend 1 bett, ext, clarge, and



BONDING RAIL SPLICE BAR



RAIL TO L-FOOT w/BONDING T-BOLT



). When the cup contacts the mobile hare, inhere and it will re-emplie to

He clarry been






DRILL SIZE

NA Please to Toy 171 that San

7/32





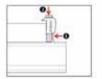

4. While applying previous to hold the clamp against the stockle point down on the mobile ode of the (lamp cap.







9




RACK SYSTEM GROUND O 1000

O believable with content of the buy's or



6. Tophen best and torque to \$5 ft dis.

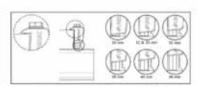

2. Soften stemp is ongaged in correct module height position and that the top of the sain is sitting level with the module flame.

NOTE When installing Alones modules, become hold by I have before positiveing claraagainst module flame. So not focus clamp softs module frame as this may damage the bending pin

DOWUL.

DEL MAR, CA 92014, USA

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PROJECT NAME 1943 AUGUSTINE HERMAN HWY KENNEDYVILLE,MD 21645 USA FRANCIS BONASS 262348

APN# 1502003538 UTILITY: DELMARVA POWER AHJ: KENT COUNTY

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11" X 17" SHEET NUMBER



Descriptive Report and Test Results

MASTER CONTRACT: 266909 REPORT: 70131735

PROJECT: 80128750

Edition 1: September 20, 2017; Project 70131735-- Albuquerque Issued by Michael Hoffnagle

April 22, 2022; Project 80116723 - Irvine Edition 17:

Prepared By: Michael Hoffingle Authorized By: Michael Hoffnagle

Edition 18: June 8, 2022; Project 80128750 - Irvine

Prepared By: Michael Hoffnagle Authorized By: Michael Hoffingle

Report pages reissned

Contents: Certificate of Compliance - Pages 1 to 6

Supplement to Certificate of Compliance - Pages 1 to 3

Description and Tests - Pages 1 to 27 Att1 Installation Manual SM- Pages 1 to 36 Att2 Schematics SM/ULA-Pages 1 to 72 Att3 Installation Manual ULA-Pages 1 to 22 Att4 RM5 Installation Guide - 1 to 19 Att5 RMDT Installation Guide - 1 to 20 Att6 RM series schematics - 1 to 32

Att7 Installation Manual, GFT Shared Rail - Pages 1 to 40

Att8 Installation Manual, GFT 4-Rail - Pages 1 to 39

Att9 GFT Schematics - Pages 1 to 42

Att10 NXT Horizon Installation Manual - Pages 1 to 22 Att11 Schematics NXT Horizon - Pages 1 to 13

PRODUCTS

CLASS - C531302 - POWER SUPPLIES - PHOTOVOLTAICS-PV Racking and clamping systems

CLASS - C531382 - POWER SUPPLIES - PHOTOVOLTAICS-PV Racking and clamping systems -

Certified to US Standards





Electrical Bonding and Grounding Test Modules

pliant modules but shows those that have been evaluated and found to be electrically compatible with the SOLARMOUNT system.

| Manufacture | Modula Model / Series | Manufacture | Module Model / Series | Manufacture | Module Model / Series |
|------------------------|---|---------------------------------------|---|-----------------|---|
| LG Electronics (cons.) | LGcon2T-IS LGcochtiK/N1WN2T/N2W)-LS LGcochtC/N1K/N2W/Q1C/Q1K)-VS LGcochtIC/N1K/N2W/Q1C/Q1K)-VS LGcochtS/V-M | Phono Solar | PScoM1-20/U PScoM1+20/U PScoM1+20/U PScoM1+20/U PScoM1+20/U | Q.Celis (cont.) | QPEAK DUD XL-G10/G10.2/G10.3/G10.c/ G10/d1 QPEAK DUD XL-G10.3/BFG QPEAK DUD XL-G10.4/BFG |
| | UKA 60HPR/HPH | PSxxxMt-2Q/UH | PSxxxM1-2Q/UH PSxxxM1H-2Q/UH | | Q.PEAK DUO XL-(G11.2/G11.3) Q.PEAK DUO XL-G11.3/BFG |
| LONGI | UR4-02014191 LR6-600 LR6-6008K/HPB/HEH/HV/PB/PE/PHI LR6-72 | Phono Solar (cont.) | PSxxxM-24/T PSxxxM-24/T PSxxxM-24/TH PSxxxM-24/TH | | RECooxAA (BLK/Pure) RECooxP (N-PEAK) RECooxP2 (Black) RECooxPE, RECooxPE72 |
| | LR6-72(BK/HV/PR/PE/PH) Resilblack LR4-60HPB | Prism Solar | P72 Series | REC | RECXXXTP.RECXXXTPY2 RECXXXTP2(HVBLK2) RECXXXTP2SP672 RECXXXTPSM (Black) RECXXXTPM (Black) |
| | RealBlack LR6-60HPB | PRICE PRICE PRICE PRICE PRICE | | | |
| Meyer Burger | Meyer Burger Black, Meyer Burger White | | | | |
| Mission Solar Energy | MSE Mono, MSE Perc | | | Renesola | All 60-ceil modules |
| Hitsubishi | ME & MLE Series | | | River | RSM Series |
| Neo Solar Power Co. | D6M Series | | | S-Energy | SN72 & SN60 Series |
| | VBHNxxxSA06/SA06B/SA11/SA11B | | Q.PEAK DUO L (G7/G7.1/G7.2/G7.3/G7.7) | SEG Solar | SEG-xxx-BMD-HV |
| Panasonic | VBHNocodALS,FALSB,FALE/SALES, VBHNocodALVBHNocoxAGS/OD- VBHNocodALT,FALTG/SALTG/SALBE, VBHNocodACT,FALTG/SALTG/SALBE, VBHNocodHX/PKI EVPhxox EVPhxox EVPhxox | | Q PEAK DUD L-(GB/GB.1/GB.2/GB.3) Q PEAK DUD L-GB.3 (GF/FF G-GGT) Q PEAK DUD X: (GP/GP.2/GP.3) Q PEAK DUD X: (GP/GP.2/GP.3) | Sesaphim | SEG-(SPA/SPE/OMA/EMA-HY/SME/E01/E11) SRP-(sGA/sG8) SRP-xxx-6MB-HY, SRP-370-375-BMB-HY, SRP-xxx-8MB-CHY, SRP-390-450-BMA-HY, SRP-xxx-8MC-HY, SRP-390-450-BMA-HY, |
| Peimar | SGxxxM (FB/8F) | | Q PEAK DUO-G10+ | Sharp | NU-SA & NU-SC Series |
| reunar | SHowM | QPEAK | Q.PEAK DUO BLK G10(+) Q.PEAK DUO BLK G10+,/AC Q.PEAK DUO (BLK) ML-G10(x) | Silfab | SLA-M, SLA-P, SLG-M, SLG-P & BC Series SILXXXBL/NT/HL/ML/BK/NX/NU/HC) |

Unless otherwise noted, all modules listed above include all wattages and specific models within that series. Variable wattages are represented as "xxx"
 Items in parenthesis are those that may or may not be present in a compatible module's model ID

Slashes? Vereven one or more thems indicates that either of those items may be the one that is present in a module's model ID.

The frame profile must not have any fisture that might circle with the bonding devices that are integrated into the racking system. Use with a manifestiment over control to the control of the c

+ Listed models can be used to achieve a Class A fire system rating for steep slope applications. See Appendix A, page A

The reader is responsible for any helidity arising from actions taken in attempted or applying the results presented in this report. This report shall not be reproduced except in full, without written appoind from CLA Group Testing & Certification for. The results of this report andy relate to those steam tested.

34 Bunsen, Irvine, CA, U.S.A. 92618 Telephone: 949.733.4300 1.800.463.6727 Fax: 949.733.4320 www.csagroup.org

DQD 507 10 Ret 2022-03-86

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SHEET NAME

SHEET SIZE

ANSI B

11" X 17" SHEET NUMBER **PV-12**

DEL MAR, CA 92014, USA

DESIGN SUPPORT DAY OF INSTALL:

CHAT.POWUR.COM



Certificate of Compliance

Certificate: 70131735

Master Contract: 266909

Project:

80128750

Date Issued:

2022-06-08

Issued To: Unirac

1411 Broadway NE

Albuquerque, New Mexico, 87102

United States

Attention: Rob D'Anastasio

The products listed below are eligible to bear the CSA Mark shown with adjacent indicators 'C' and 'US' for Canada and US or with adjacent indicator 'US' for US only or without either indicator for Canada only.

Issued by: Michael Hoffnagle



PRODUCTS

CLASS - C531302 - POWER SUPPLIES - PHOTOVOLTAICS-PV Racking and clamping systems CLASS - C531382 - POWER SUPPLIES - PHOTOVOLTAICS-PV Racking and clamping systems -Certified to US Standards

Certificate: 70131735 Project: 80128750

Master Contract: 266909 Date Issued: 2022-06-08

| Models: | SM | SOLARMOUNT Flush-to-Roof is an extruded aluminum rail PV racking system that is installed parallel to the roof in landscape or portrait orientations. |
|---------|-----|---|
| | ULA | Unirac Large Array is a ground mount system using the SolarMount (SM) platform for the bonding and grounding of PV modules. |

Solarmount

The system listed is designed to provide bonding/grounding, and mechanical stability for photovoltaic modules. The system is secured to the roof with the L-Foot components through the roofing material to building structure. Modules are secured to the racking system with stainless steel or abuninum mid clamps and Aluminum end clamps. The modules are bonded to the racking system with the stainless-steel bonding mid clamps with piercing points. The system is grounded with 10 AWG copper wire to bonding/grounding lugs. Fire ratings of Class A with Type 1, 2, 3 (with metallic frame), 4 (with trim), 5 (with trim), 10(with metallic frame), 19, 22, 25, 29, or 30 for steep slope. Tested at 5" interstitial gap which allows installation at any stand-off height.

The grounding of the system is intended to comply with the latest edition of the National Electrical Code, to include NEC 250 & 690. Local codes compliance is required, in addition to national codes. All grounding bonding connections are to be torqued in accordance with the Installation Manual and the settings used during the certification testing for the current edition of the project report.

The system may employ optimizers inicro-inverters and used for grounding when installed per installation instructions.

UL 2703 Mechanical Load ratings:

| Downward Design Load (lb/fl ²) | 113.5 |
|--|-------|
| Upward Design Load (lb/ft²) | 50.7 |
| Down-Slope Load (lb/ft ¹) | 16.13 |

Test Loads:

| Downward Load (lb/fl ²) | 170.20 |
|---------------------------------------|--------|
| Upward Load (lb/ft²) | 76.07 |
| Down-Slope Load (lb/fl ²) | 24.2 |



DEL MAR, CA 92014, USA

DESIGN SUPPORT DAY OF INSTALL: CHAT.POWUR.COM

| V | ERSION | |
|-----------------|------------|-----|
| DESCRIPTION | DATE | REV |
| INITIAL RELEASE | 01/11/2023 | UR |
| | | |
| | | |
| | | |

FRANCIS BUINCLE.

11943 AUGUSTINE HERMAN HWY,
KENNEDYVILLE, MD 21645 USA

TOWNSESS UTILITY: DELMARVA POWER AHJ: KENT COUNTY

SHEET NAME

SPEC SHEETS

SHEET SIZE ANSI B 11" X 17"

SHEET NUMBER



02-01-2023

Powur PBC

2683 Via De La Valle #321G

Subject: Structural Certification for Installation of Residential Solar

re job: Francis Bonass (262346)

11943 Augustine Herman Hwy, Kennedyville, MD 21645, USA

Attn.: To Whom It May Concern

Observation of the condition of the existing framing system was performed by an audit team of Powur PBC

After review of the field observation data, structural capacity calculations were performed in accordance with applicable building codes to determine adequacy of the existing roof framing supporting the proposed panel layout. Please see full Structural Calculations report for details regarding calculations performed and limits of scope of work and liability. The design criteria and structural adequacy are summarized below:

Design Criteria:

Code: IBC 2015, ASCE 7-10, Ult Wind Speed: 115 mph, Ground Snow: 25 psf, Min Snow Roof: 0 psf

ROOF 1: Shingle roofing supported by 2x4 Rafter @ 24 in. OC spacing. The roof is sloped at approximately 26 degrees and has a max beam span of 8.4 ft between supports. Roof is adequate to support the imposed loads. Therefore, no structural upgrades are required.

ROOF 2: Shingle roofing supported by 2x4 Rafter @ 24 in. OC spacing. The roof is sloped at approximately 10 degrees and has a max beam span of 9.0 ft between supports. Roof is adequate to support the imposed loads. Therefore, no structural upgrades are required.

Current Renewables Engineering Inc. Professional Engineer info@currentrenewableseng.com 02-01-2023





United States Department of the Interior FISH AND WILDLIFE SERVICE



Maryland Fishery Resources Office 177 Admiral Cochrane Dr. Annapolis, MD 21401

RE: Cypress Branch Dam Removal Project in Kent County, Millington, Maryland, NHPA Section 106 Compliance, Invite to Potential Consulting Parties

Dear Mr. Carper and Ms. Gerber,

The purpose of this letter is to inform you of the Cypress Branch Dam Removal Project in Kent County, Millington, Maryland, and to invite you to become a consulting party in the Section 106 consultation process in accordance with the National Historic Preservation Act (NHPA). The U.S. Fish and Wildlife invites the Kent County Historic Preservation Commission to consult in the removal of the Cypress Branch Dam Removal Project, considered an undertaking under the National Historic Preservation Act (NHPA).

The United States Fish and Wildlife Service (USFWS), acting as the lead federal agency is entering into the Section 106 consultation process in accordance with the NHPA with the State of Maryland – Maryland Department of Natural Resources (dam owner) and the Maryland Historical Trust with additional consultation partners including American Rivers.

Cypress Branch Mill Pond Dam is located on Maryland Department of Natural Resources (MD DNR), Maryland Park Service land in Millington, MD. The GPS coordinates for the project are 39.261159, -75.827442. The Cypress Branch Mill Pond Dam Removal project is a cooperative effort by the MD Department of Natural Resources, the U.S. Fish and Wildlife Service, and American Rivers. Primary funding for the project is from the USFWS from the Hurricane Sandy Resilience Fund. Through a grant agreement with the USFWS, the design and construction of the project will be administered by American Rivers. The purpose of the dam removal is to restore Cypress Branch to riverine conditions to ensure fish and aquatic species can pass upstream and downstream without impediments (see attached USGS Site Location Maps and Aerial Overview Map). The priority species for this dam removal project are Blueback Herring and Alewife, two migratory species that move upstream to spawn each spring and return downstream after they have spawned.

The Cypress Branch Mill Pond Dam has been determined eligible for listing on the National Register of Historic Places (NRHP) under criterion A due to its significance to the Historic District. The exact construction date of the Cypress Mill Dam is unknown, there is a history of dams and mill ponds in the area starting in the eighteenth century. However, based on the aggregate in the concrete, H&P estimates that the Dam was constructed 1900 c. Eligibility was determined due to trends in history related to the mill history of the area and the Town of Millington. Based on the deed and historical research conducted for the project, it appears that

the Cypress Mill Pond and Dam funneled water to mill races that powered mills in the Town of Millington. Since the dam is eligible for the NRHP, removal will cause an Adverse Effect and will require a Memorandum of Agreement (MOA). USFWS is collaboratively working with the State of Maryland, Maryland Historic Trust, and interested parties to determine appropriate mitigation measures and will collaboratively develop the MOA these parties. Please note that the project team, in concurrence with the Maryland Historic Trust, believe that the undertaking will have no effect on significant archeological resources and that no further archeological investigations are warranted for this undertaking.

We respectfully request your response to me by June 23, 2023, if your organization would like to serve as a consulting party in the section 106 consultation. It is assumed that if USFWS is not contacted by this date that your organization is not interested in serving as a consulting party. Please call (410-852-6201) or email me (alexander vidal@fws.gov) of your interest to participate or if you have questions about this request.

Sincerely,

Alexander Vidal
Fish and Wildlife Biologist
US Fish and Wildlife Service
Maryland Fish and Wildlife Conservation Office

CC: Ms. Jessie Thomas-Blate, American Rivers

Mr. Mark Secrist, US Fish and Wildlife Service

Mr. Jim Thompson, MD Department of Natural Resources

Ms. Becky Roman, Maryland Historical Trust

Mr. Shane Johnston, MD Department of Natural Resources



Figure 1. Top of the Earthen Dam at Cypress Branch



Figure 2. cement spillway on Cypress Branch to be removed looking upstream toward Mill Pond



Figure 3. Side view of cement spillway looking upstream toward the Mill Pond


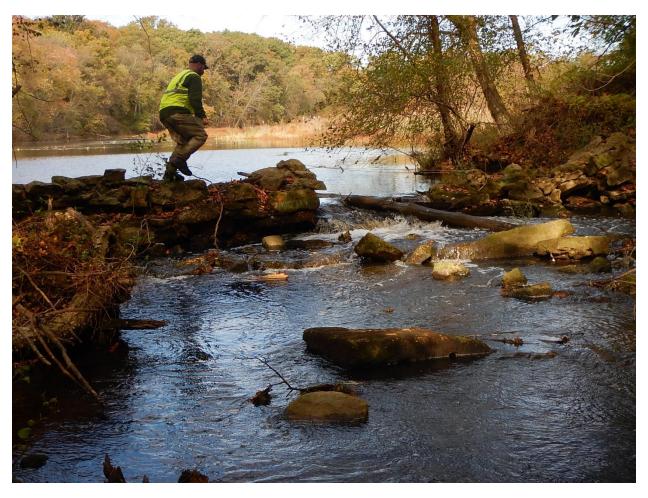


Figure 4. Rubble and cement at breach in earthen dam looking upstream toward Mill Pond




- NOTES:
 1, Umit of disturbance is approximate.
 2. Streams digitized using 2019 ortholmagery.
 3. 2019 ortholmagery obtained from MD IMAP website: Imap.maryland.gov/

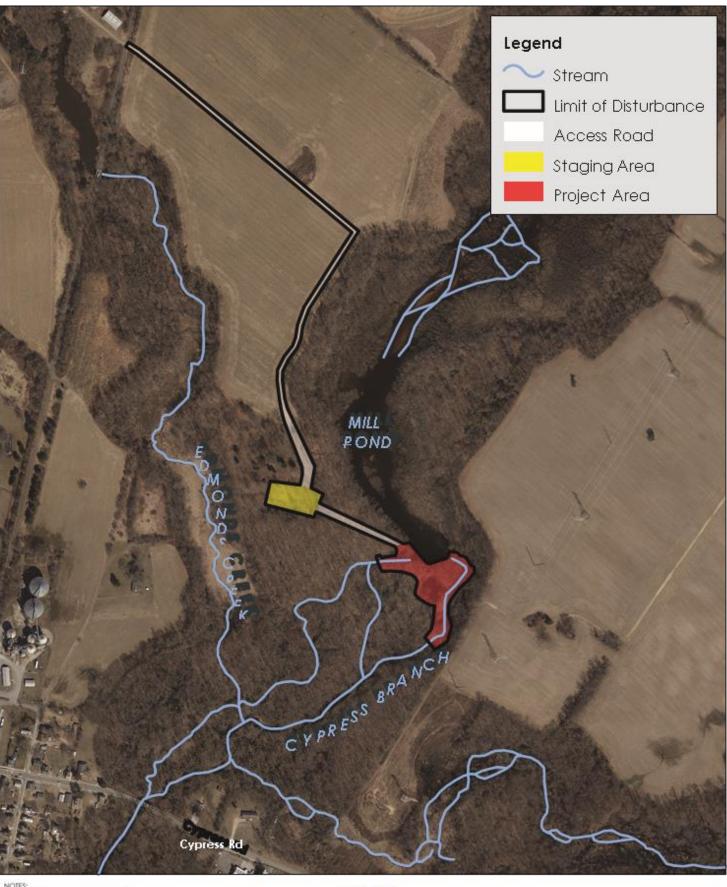

AERIAL **OVERVIEW MAP**

CYPRESS BRANCH DAM REMOVAL AMERICAN RIVERS KENT COUNTY, MARYLAND



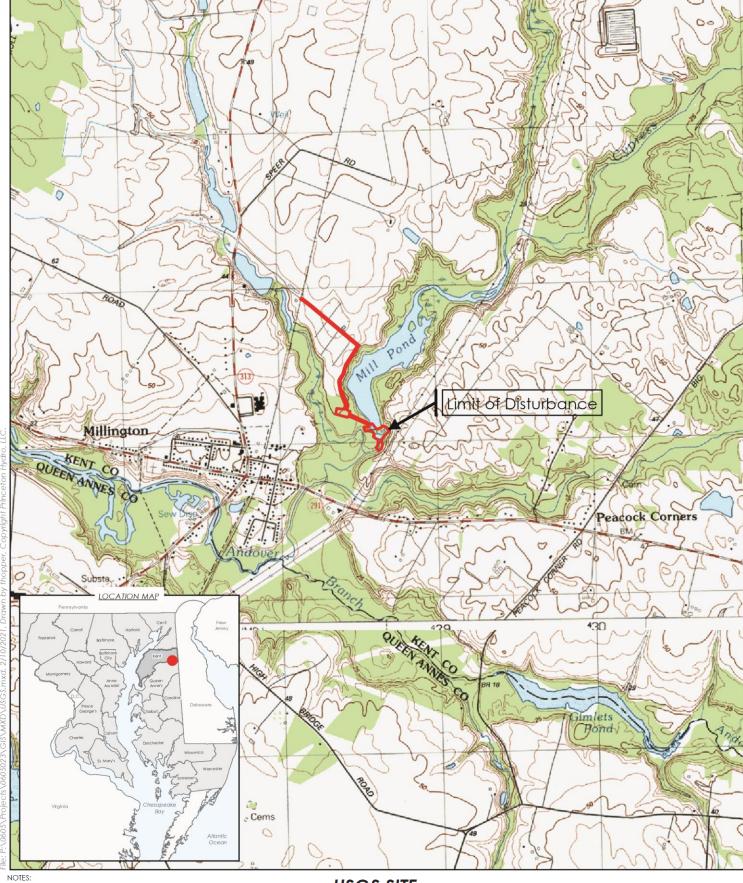

- NOTES:

 1. Limit of disturbance is approximate.

 2. USGS topographic digital raster graphics obtained from Terrain Navigator Pro, Millington and Sudlersville, MD quadrangles.





USGS SITE LOCATION MAP

CYPRESS BRANCH DAM REMOVAL AMERICAN RIVERS KENT COUNTY, MARYLAND

